
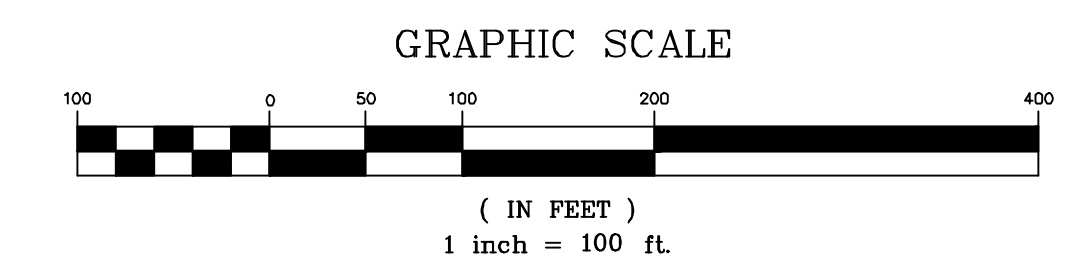


PROPOSED DRIVEWAY PIPE SIZES

LOT NUMBER	DRIVEWAY PIPE SIZE (INCH DIAMETER)
1	18
2	18
3	18
4	18
5	18
6	18
7	18
8	18
9	18
10	18
11	18
12	18
13	18
14	18
15	18
16	18
17	18
18	18
19	24
20	24
21	24
22	18
23	18
24	18
25	18
26	18
27	18
28	18
29	18
30	18
31	18
32	18
33	18
34	24
35	24
36	18
37	18
38	18
39	18
40	18
41	18
42	18
43	18
44	18
45	18
46	18
47	18
48	18
49	18
50	18
51	18
52	18
53	18
54	18
55	18
56	18
57	18
58	18
59	18
60	18
61	18
62	18
63	18
64	18
65	18
66	18
67	18
68	18
69	18
70	18
71	18
72	18
73	18
74	18


LEGEND	EXISTING	PROPOSED
EDGE OF PAVEMENT	---	---
WATER LINE	W---	W---
STORM DRAINAGE PIPE	---	---
WOODS LINE	---	---
OVERHEAD ELECTRICAL LINE	OE---	OE---
DROP INLET	---	---
UTILITY POLE	U	U
LIGHT POLE	L	L
GUY WIRE	G	G
HYDRANT	H	H
VALVE	V	V
CONTOUR	---	---
ELEVATION	+ 100.00	
LIMIT OF DISTURBANCE		LOD
LIMIT OF DISTURBANCE AT SILT FENCE		LOD/SF
SILT FENCE		SF
END/BEGIN SILT FENCE		□
STRAW & NET LINER		▨
STRAW WATTLE		---
STRAW WATTLE		---
RIP RAP APRON		▴
TEMPORARY HORSESHOE INLET		⤿
TEMPORARY CHECK DAM		⤿
TEMPORARY GRAVEL CONSTRUCTION ENTRANCE/EXIT		⤿
TEMPORARY SKIMMER BASIN		⤿
SILT BAG		SB
SOIL STABILIZATION WITH TEMPORARY SEEDING WITHIN 7 DAYS		▨

DRAWING INDEX	
C1.0	TITLE SITE
C1.1	EXISTING SITE
C1.2	ARTHUR'S CREEK DRIVE
C1.3	ARTHUR'S CREEK DRIVE
C1.4	BETHANY PLACE & CHIP PLACE
C1.5	MARY KATHERINE DRIVE
C1.6	JACOB'S PLACE & KRISTY LANE
C1.7	DITCH 'A' PLAN & PROFILE
C1.8	CROSS SECTIONS
C1.9	EROSION CONTROL
C1.10A	EROSION CONTROL
C1.10B	EROSION CONTROL
C1.11	EROSION CONTROL
C1.12A	EROSION CONTROL
C1.12B	EROSION CONTROL
C5.1	DETAILS-EROSION CONTROL
C5.2	DETAILS-EROSION CONTROL
C5.3	DETAILS

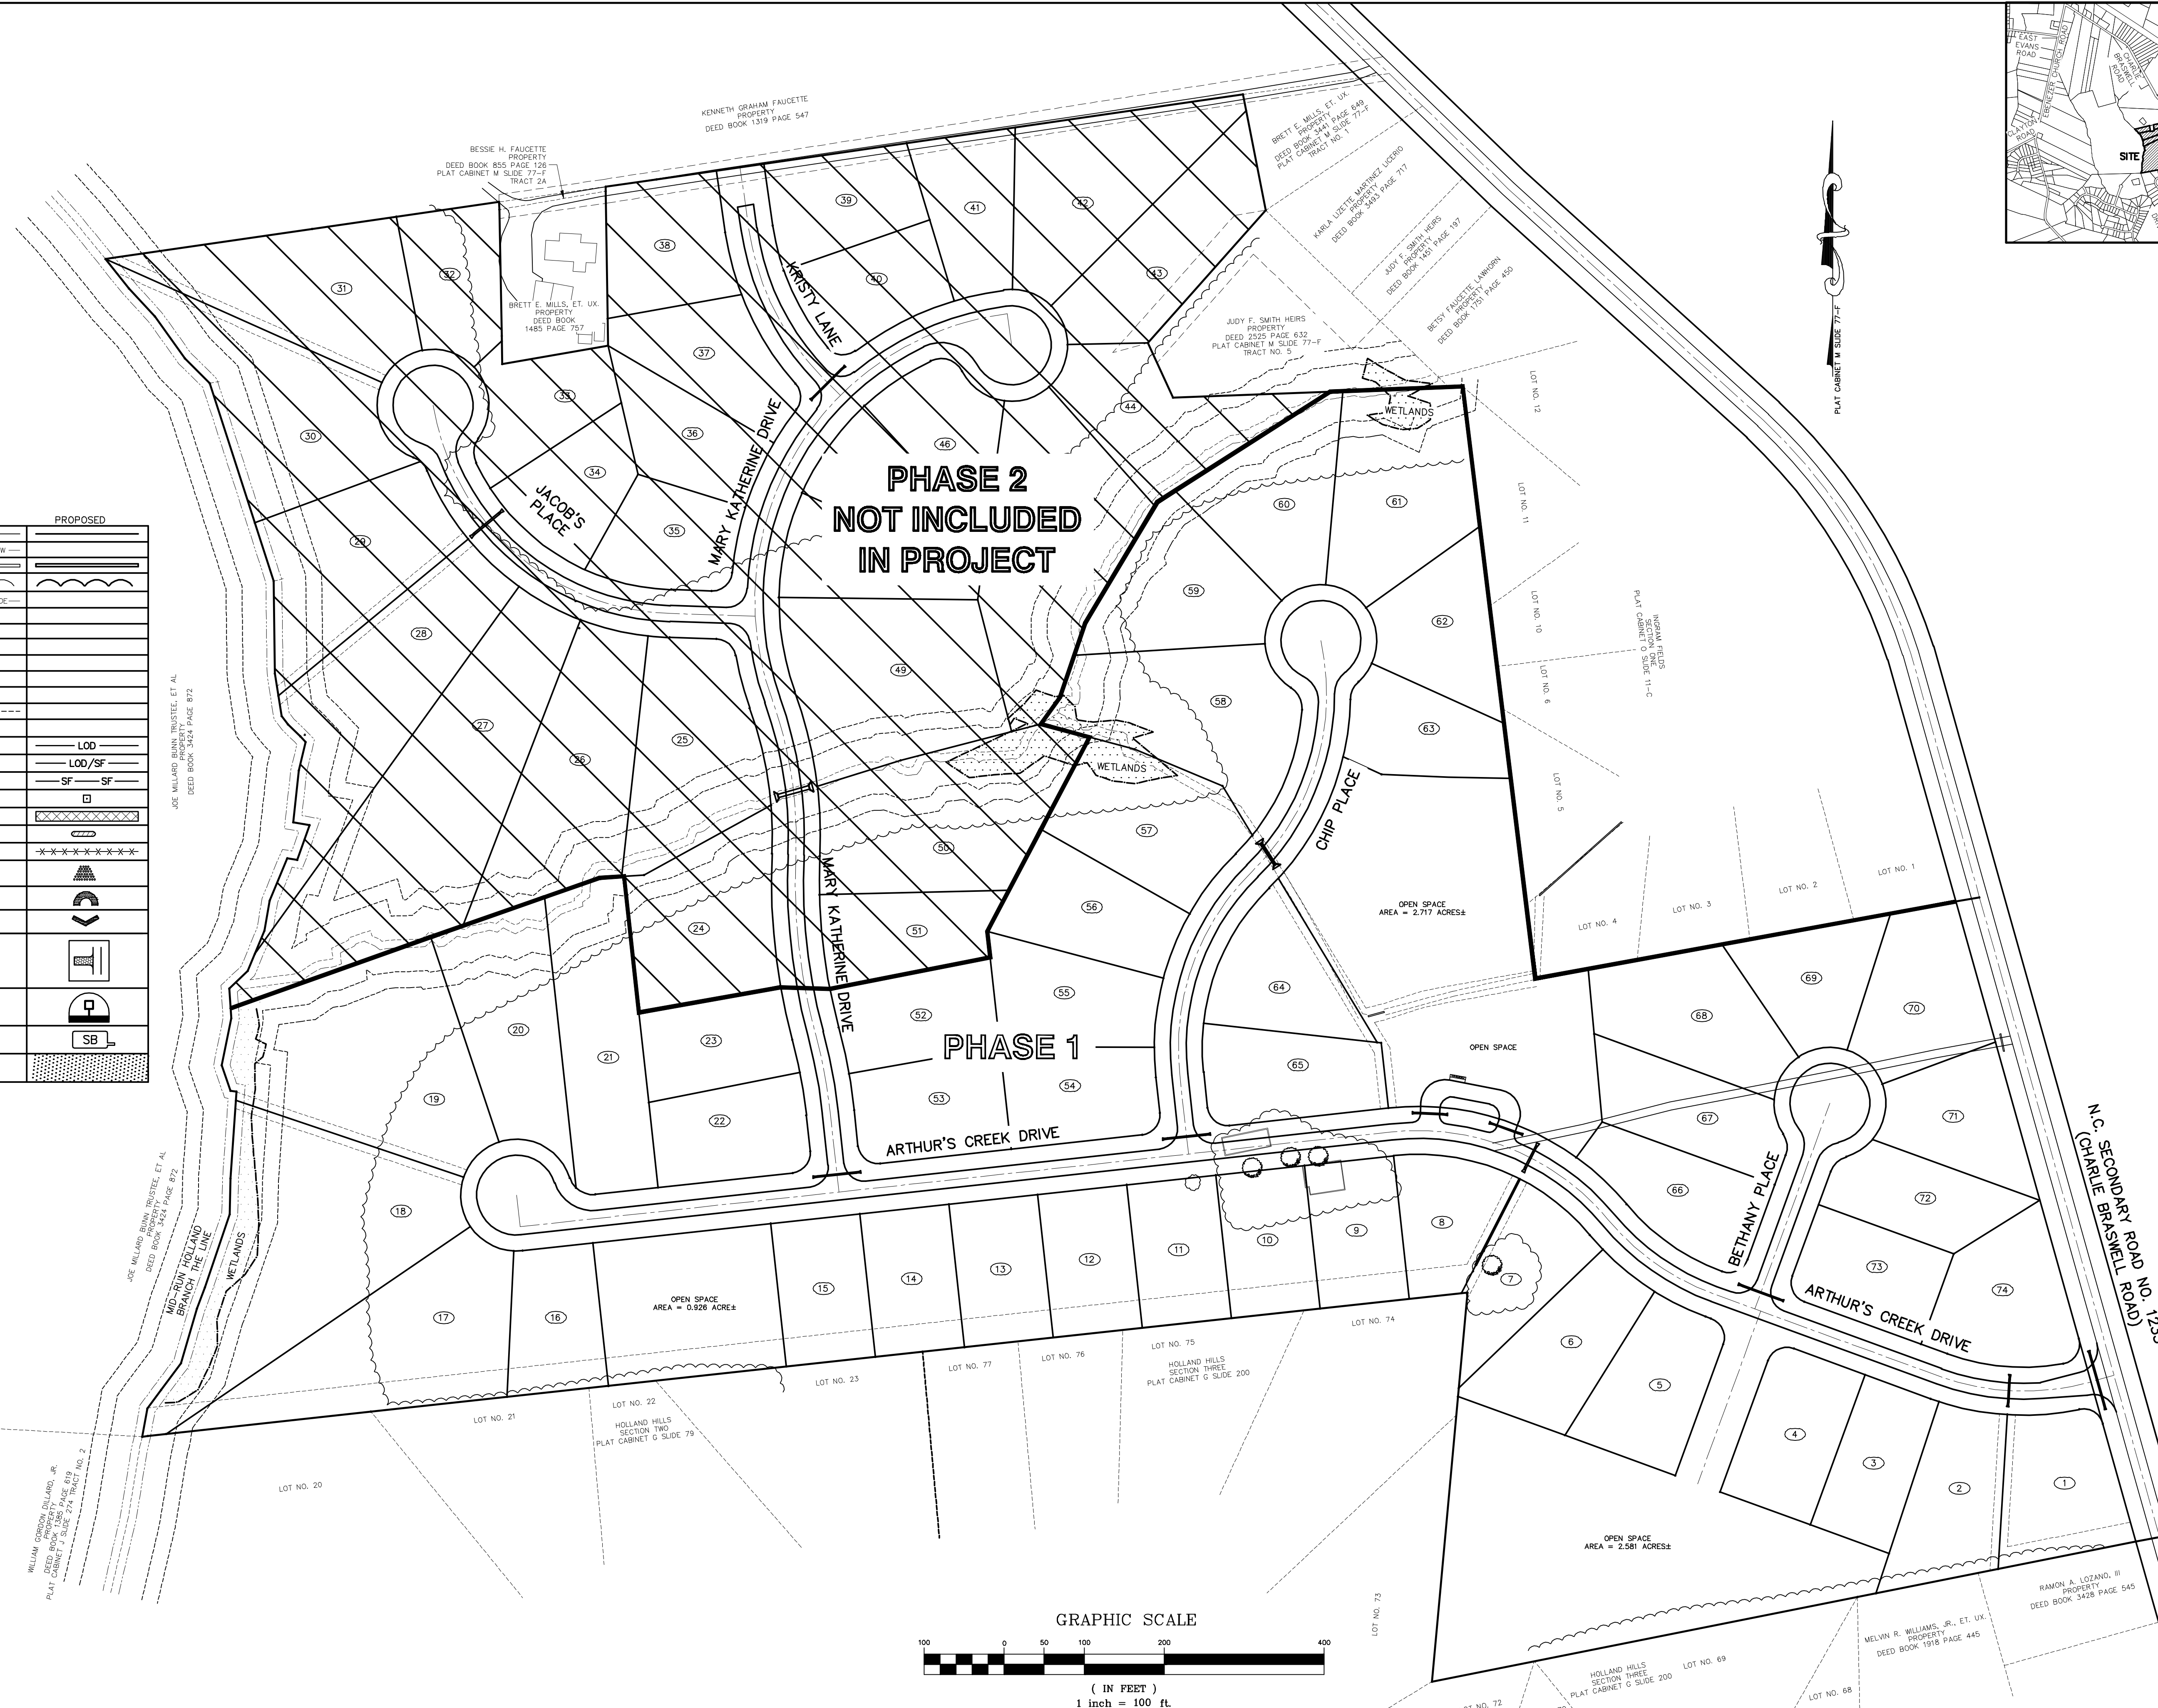

NO.	REVISION	DATE

B. R. KORNEGAY, INC.
 LAND SURVEYING • ENGINEERING • PLANNING
 License Number: F-1054
 300 East Walnut Street
 Goldsboro, N.C. 27530
 www.kornegaysep.com (919) 735-5886 Fax:(919) 580-9053

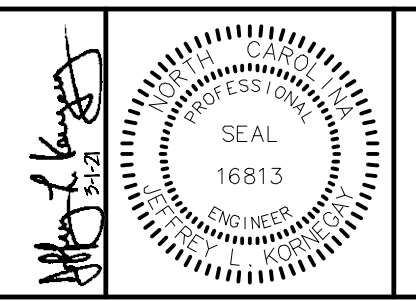

TITLE SHEET

DRAWN BY: JLK
 DESIGNED BY: JLK
 DATE: 3-1-2021
 SCALE: 1" = 100'

ARTHUR'S CREEK
 FORK TOWNSHIP
 WAYNE COUNTY, N.C.

SHEET:
C1.0
 OF:
 WORK ORDER:
 210018
 CADD DWG:
 210018